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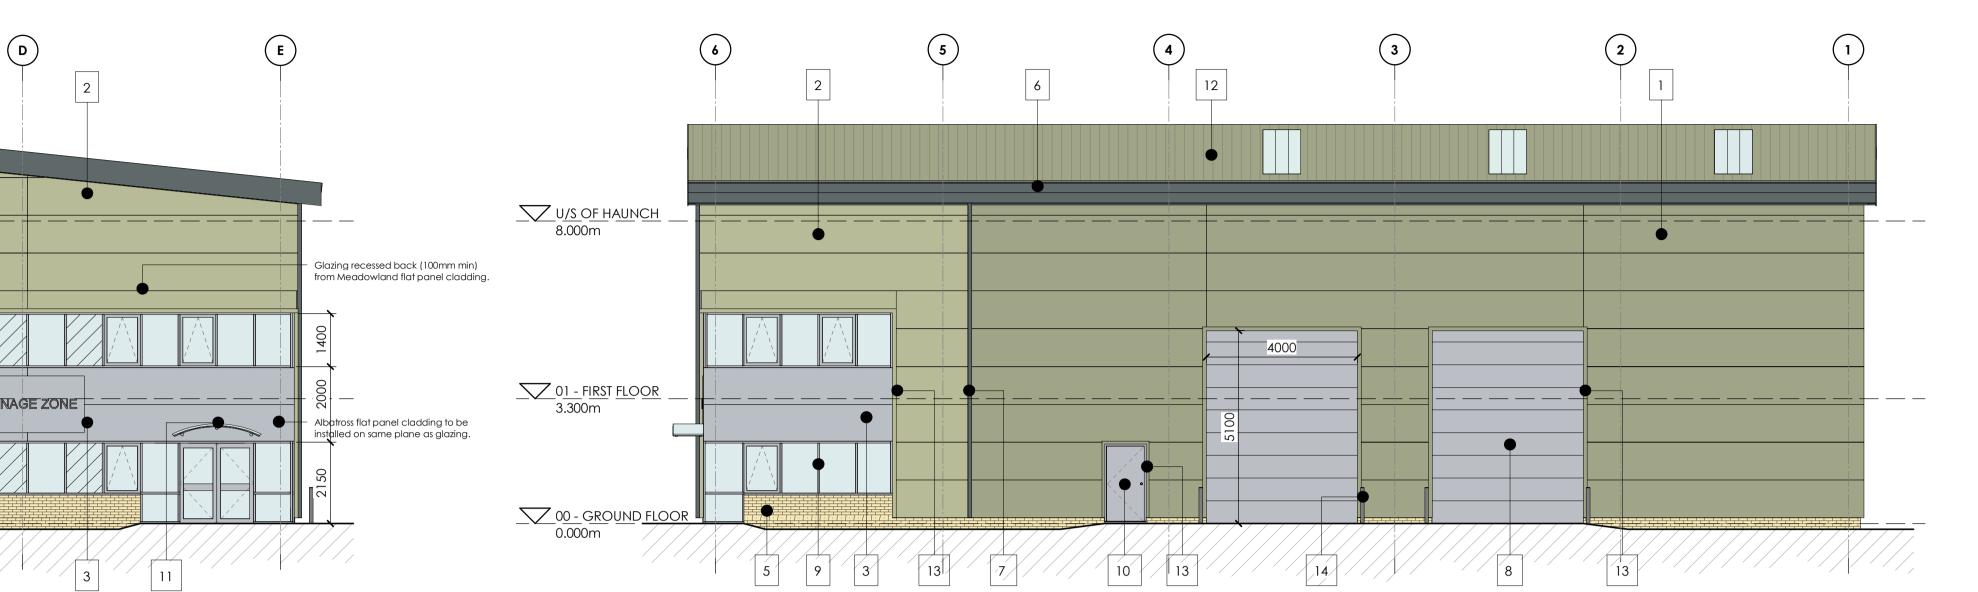
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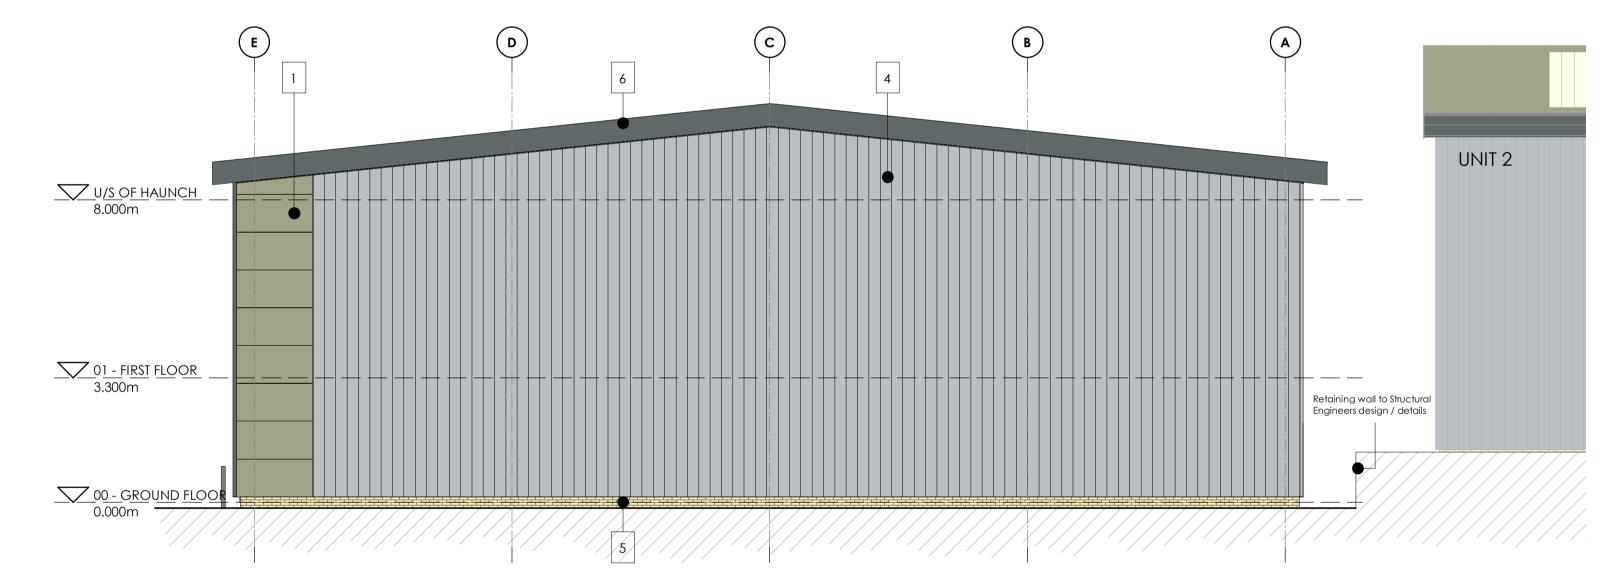
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and request updated data if required.



NORTH EAST ELEVATION

1:100



Metal trim / flashing to protrude from the main body of flat panel cladding, giving the elevation a sense of depth.

NORTH WEST ELEVATION

UNIT 2

U/S OF HAUNCH

O1 - FIRST FLOOR

00 - GROUND LOOR 0.000m

SOUTH EAST ELEVATION

Retaining wall to Structural

Engineers design / details —

1:100

1:100 12 U/S OF HAUNCH 8.000m 01 - FIRST FLOOR 3.300m 00 - GROUND FLOOR
0.000m Trapezoidal cladding and flat panel cladding to be installed on same plane.

SOUTH WEST ELEVATION

1:100

This drawing is to be read in conjunction with all other
relevant Architects, Engineers & Sub - Contractors
drawings / Details.

This drawing is subject to Client and Building Control Approval.

Final Steelwork and grid layout is subject to specialist steel design.

Any foundations / floor slab shown are diagramatic and subject to specialist design / details.

			Scale 1 : 100_		
0 1	2	5		10 m	

KEY	MATERIAL SPECIFICATION	MATERIAL COLOUR	TATA STEEL CODE
1	Tata Trimapanel micro-rib (or similar approved) panel cladding system, with factory finish.	Moorland Green	12B21
2	Tata Trimapanel micro-rib (or similar approved) panel cladding system, with factory finish.	Meadowland	12B17
3	Tata Trimapanel micro-rib (or similar approved) panel cladding system, with factory finish.	Albatross	18B17
4	Tata Trisomet (or similar approved) trapezoidal cladding system, with factory finish.	Albatross	18B17
5	Brickwork	Buff Brick + Natural M	ortar N/A
6	PPC aluminium (or similar approved) facias and soffits	Merlin Grey	18B25
7	Factory finished steel feature flashings	Merlin Grey	18B25
8	Insulated sectional overhead loading doors, with factory finish.	RAL 9006	N/A
9	PPC aluminium windows/door frames, double galzed with anti-sun glass.	RAL 9006	N/A
10	High security factory finished steel pedestrian doors	RAL 9006	N/A
11	Glass canopy, with painted steel frame	RAL 9006	N/A
12	Tata Trisomet (or similar approved) trapezoidal roof cladding system, with factory finish.	Moorland Green	12B21
13	Factory finished steel flashings	To match cladding	N/A
14	Bollards	Gloss painted steel RA 9006 with yellow horiz stripes.	

D.5		15.4		10.07.00
P5	Minor amendment.	IR <	=3\\\	10.07.23
P4	Glazing amended.	IR —	3860	29.06.23
P3	Unit 2 added for context, metal trim note amended.	IR	SW	30.05.23
P2	First floor windows amended to have panels above opening lights, 600mm cladding panel removed below window.	IR	SW	16.05.23
P1	Issued for Planning	IR	SW	20.04.23
ev	Description	Drn	Vf'd	Date
can us the de Regul	lined in section 2.3 of the CITB Industry Guidance to sually be ignored, as can risks arising from routine cosign compounds or significantly alters these risks. In ations 8, 9 and 11, any significant risks relating to the awing have been identified and are annotated thu	onstructio accordo design fe	n activiti ance with	es, unless n CDM
X	No significant risks have been identified.			
Significant risks have been identified - refer to notes on drawing for information on residual risks and any control measures to be employed.				

Designer's Signature

Drawing Status

Refer to the current Designer's Risk Assessment sheets for further details. Date Mar'23

PLANNING

architecture: engineering: building consultancy

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Also at Leeds, Lincoln & Wirksworth				
Project				
Proposed Development, Rockingham.				
Client				
Carnell Management Services Ltd.				
Title				
Unit 1 Proposed Elevations				
WS Project No. 12215	Drawn by	Date Mar'23	Scale As indicated @ A1	

12215 - WMS - 01 - ZZ - D - **A - 10601 -** S8 - P5