



NORTH EAST ELEVATION

1:100

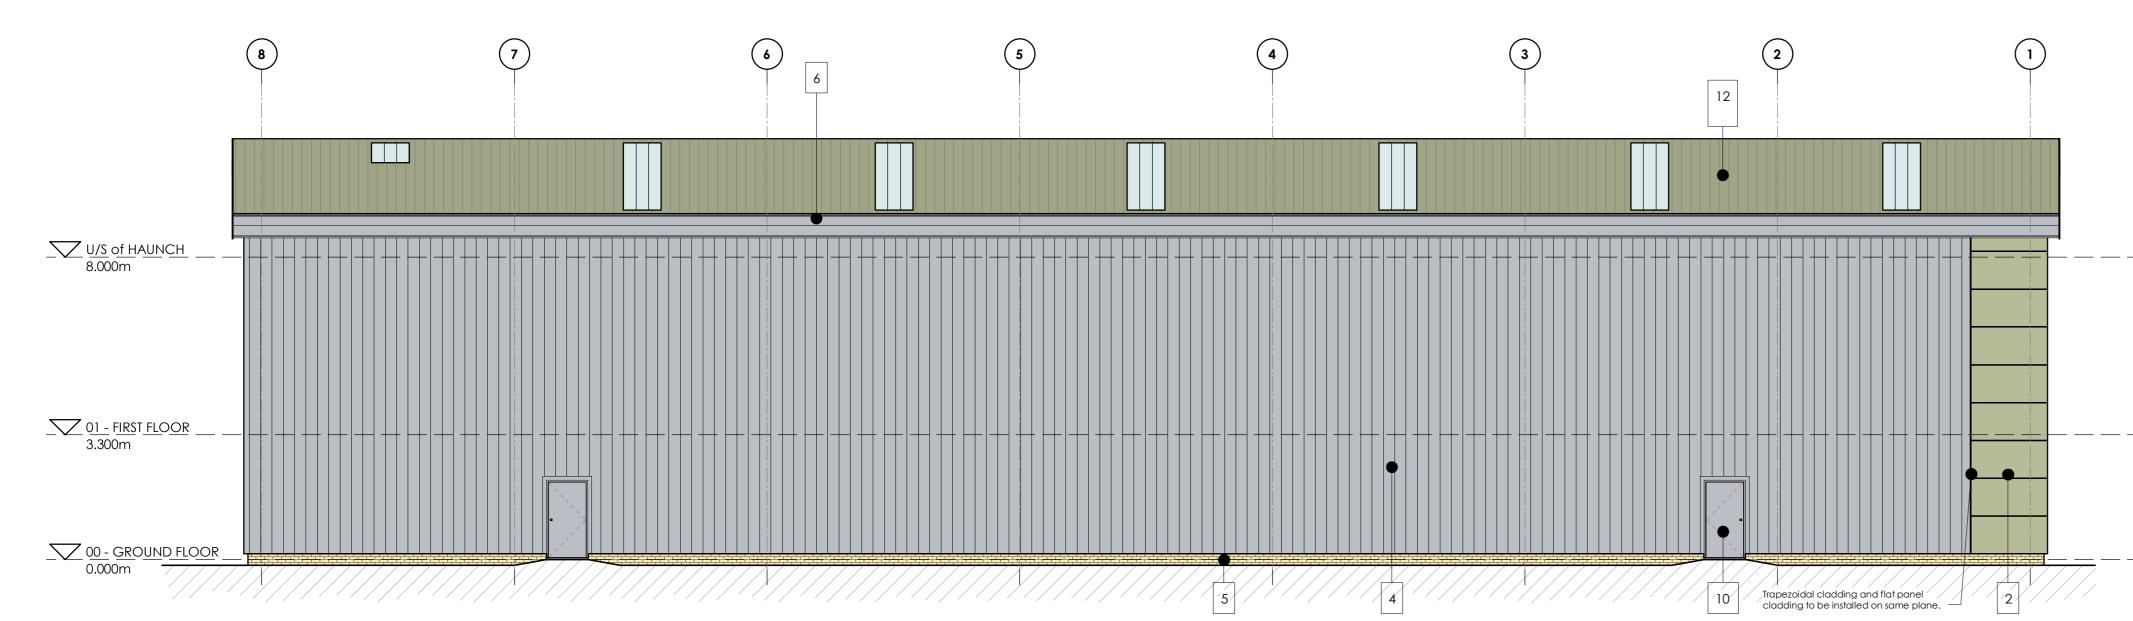

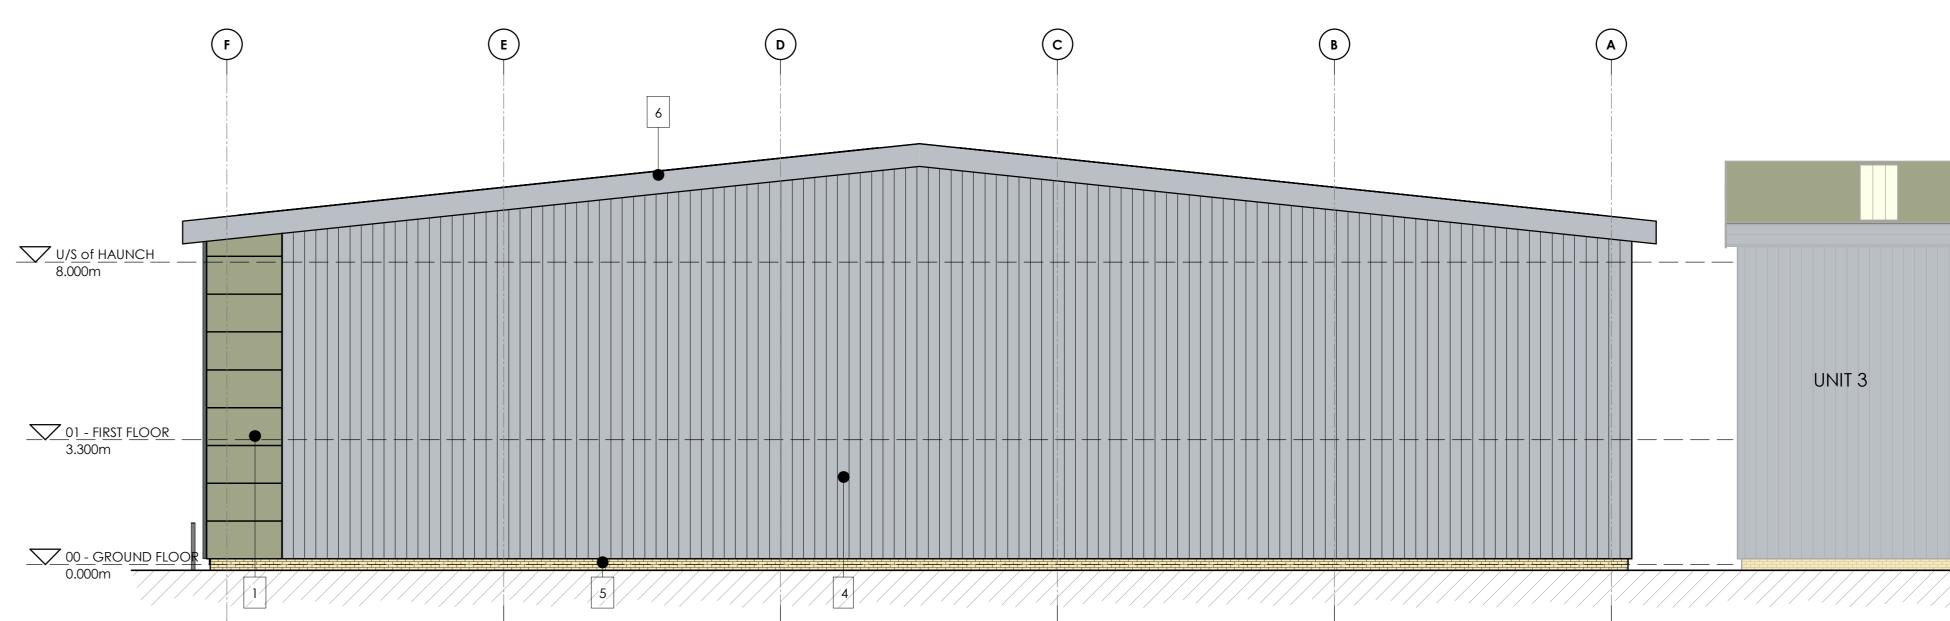

NORTH WEST ELEVATION

1:100

A	В	C	D	E	F
	6°				
U/S of HAUNCH 8.000m					
				2700	
01 - FIRST FLOOR			 		
2250				2700	
00 - GROUND FLOOR 0.000m					
0.000m				144 44	43 A A A A A A A A A A A A A A A A A A A

SOUTH WEST ELEVATION
1:100

GA SECTION 1:100

KEY	MATERIAL SPECIFICATION	MATERIAL COLOUR	TATA STEEL CO	
1	Tata Trimapanel micro-rib (or similar approved) panel cladding system, with factory finish.	Moorland Green	12B21	
2	Tata Trimapanel micro-rib (or similar approved) panel cladding system, with factory finish.	Meadowland	12B17	
3	Tata Trimapanel micro-rib (or similar approved) panel cladding system, with factory finish.	Albatross	18B17	
4	Tata Trisomet (or similar approved) trapezoidal cladding system, with factory finish.	Albatross	18B17	
5	Brickwork	Buff Brick + Natural Mortar	N/A	
6	PPC aluminium (or similar approved) facias and soffits	Albatross	18B17	
7	Factory finished steel feature flashings	Merlin Grey	18B25	
8	Insulated sectional overhead loading doors, with factory finish.	RAL 9006	N/A	
9	PPC aluminium windows/door frames, double galzed with anti-sun glass.	RAL 9006	N/A	
10	High security factory finished steel pedestrian doors	RAL 9006	N/A	
11	Glass canopy, with painted steel frame	RAL 9006	N/A	
12	Tata Trisomet (or similar approved) trapezoidal roof cladding system, with factory finish.	Moorland Green	12B21	
13	Factory finished steel flashings	To match cladding	N/A	
14	Trespa Panelling	Multicoloured	N/A	
15	Bollards	Gloss painted steel RAL 9006 with yellow horizontal stripes	N/A	

P5	Minor amendment		IR	544 L	10.0	
P4 P3	Glazing amended. first floor level amended context.	d, unit 3 shown for	IR IR	SW	29.0 31.0	
P2	First floor windows amer panels above opening cladding panel remove	lights, 600mm	IR	SW	16.0	
P1	Issued for Planning.		IR	SW	21.0	
Rev	Description		Drn	Vf'd	Do	
	No significant risks have be significant risks have be drawing for information of measures to be employed.	n identified - refer to n n residual risks and an d.	y control			
Refe	er to the current Designer's Ris	K Assessment sneets to	r turtner o	aetails.		
De	signer's Signature	SW	Do	Date April'23		
Dro	awing Status	LANNING				
•	villiam chitecture : engin	_				
Ca	wark Beacon fferata Way, wark-on-Trent,	Te W		01636 saunde		

William Saunders is the trading name of Wm Saunders Partnership LLP. Wm Saunders Partnership LLP is registered in England and Wales with the Registration number OC 308323. The Registered Office is Ossington Chambers, 6-8 Castle Gate, Newark on Trent, Notts, NG24 1 AX.

This drawing and any design thereon is the copyright of William Saunders and must not be reproduced without its written consent.

Contractors must verify all dimensions, levels and co-ordinates at the site before commencing any work or making any shop drawings: no dimensions shall be measured from the drawing if in doubt, ask William Saunders for confirmation.

Hard copies or PDF versions of drawings will always take precedence over CAD data.
Furthermore, William Saunders does not undertake to issue data revisions as a matter of course.
It is the recipient's responsibility to assess the impact of hard copy or PDF versions of drawings and request updated data if required.

Nothing on this drawing confers or purports to confer on any third party any benefit under the Contracts (Rights of Third Parties) Act 1999.

This drawing is to be read in conjunction with all other relevant Architects, Engineers & Sub - Contractors

This drawing is subject to Client and Building Control

Final Steelwork and grid layout is subject to specialist steel

Any foundations / floor slab shown are diagramatic and

subject to specialist design / details.

drawings / Details.

design.

Proposed Development, Rockingham

Nottinghamshire, NG24 2TN.

Also at Leeds, Lincoln & Wirksworth

Carnell Management Services Ltd.

Unit 4 - Proposed Elevations & GA Section WS Project No. Drawn by Date Scale As indicated @ A0

Drawing/Document Reference

12215 - WMS - 04 - ZZ - D - **A - 10604 -** S8 - P5