

PROPOSED SIDE ELEVATION  
SCALE: 1:200



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**PROPOSED ELEVATIONS FINISHES LEGEND**

- COLOURED STEEL FLAMING  
COLOUR: RAL 7011
- WINDFAN KEYS WITH MICRO-SEE VIEW  
EXTERNAL CLADDING METAL PANEL COATING  
COLOUR: PURE GREY RAL 9010
- PAINTED, COATED TOP SHEET CLADDING  
COLOUR: PURE GREY RAL 9010
- EXISTING TRAPEZOIDAL CLADDING FINISHED IN GREEN
- UNITED CLADDING TO MATCH EXISTING BUILDINGS
- BUFF BRICKWORK IN STRETCHER BOND

OFFICE WITH WINDFAN KEYS TO MATCH WALL CLADDING  
OFFICE WITH WINDFAN KEYS TO MATCH WALL CLADDING  
ROOF PITCH: 4% GABLES TO MATCH EXISTING BUILDINGS  
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CLADDING TO MATCH WALL CLADDING  
EXTERNAL WINDFAN KEYS TO MATCH WALL CLADDING

**Notes:**

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All dimensions are in millimetres unless stated otherwise.

It is recommended that information is not scaled off this drawing.

This drawing should be read in conjunction with all other relevant information, specifications & schedules.

If this drawing is received electronically it is the recipient's responsibility to print the document at the correct scale.

All dimensions to be checked on site prior to commencing work and any discrepancies to be advised immediately.


CONSTRUCTION (Design & Management) REGULATIONS 2015: David Trundley Design Services Ltd are employed as 'Designer' and will provide information to those responsible for the 'Principal Designer' and to the client.

David Trundley Design Services Ltd are responsible for the 'Architectural' design of the elements included on this drawing only.


Architectural design has been carried out with due consideration for the safety during construction, occupation and maintenance of the finished structure.

The works contain no extraordinary hazards or risks that are not present during routine construction operations that would not readily be apparent to a competent contractor.



This information should be included as part or commencement of the Health and safety file for the project.

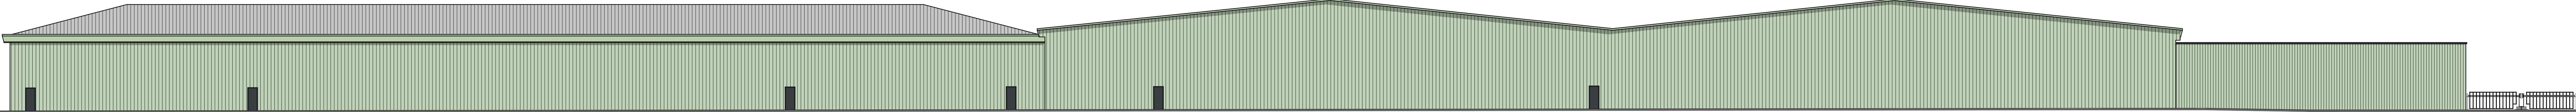

PROPOSED REAR ELEVATION  
SCALE: 1:200

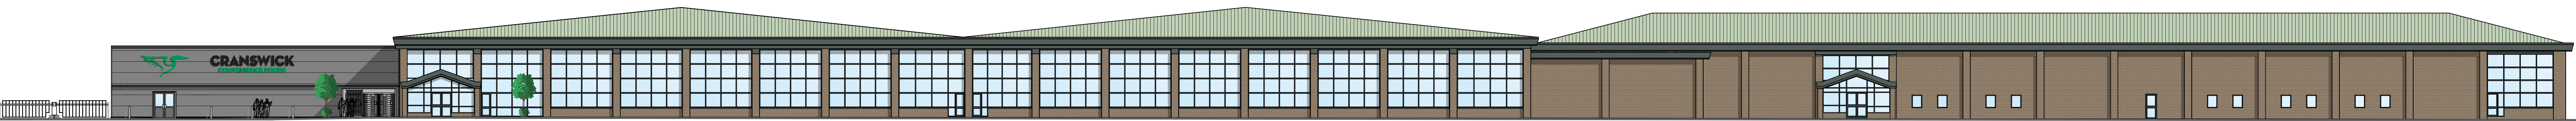

PROPOSED FRONT ELEVATION  
SCALE: 1:200

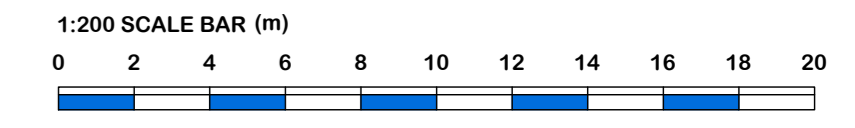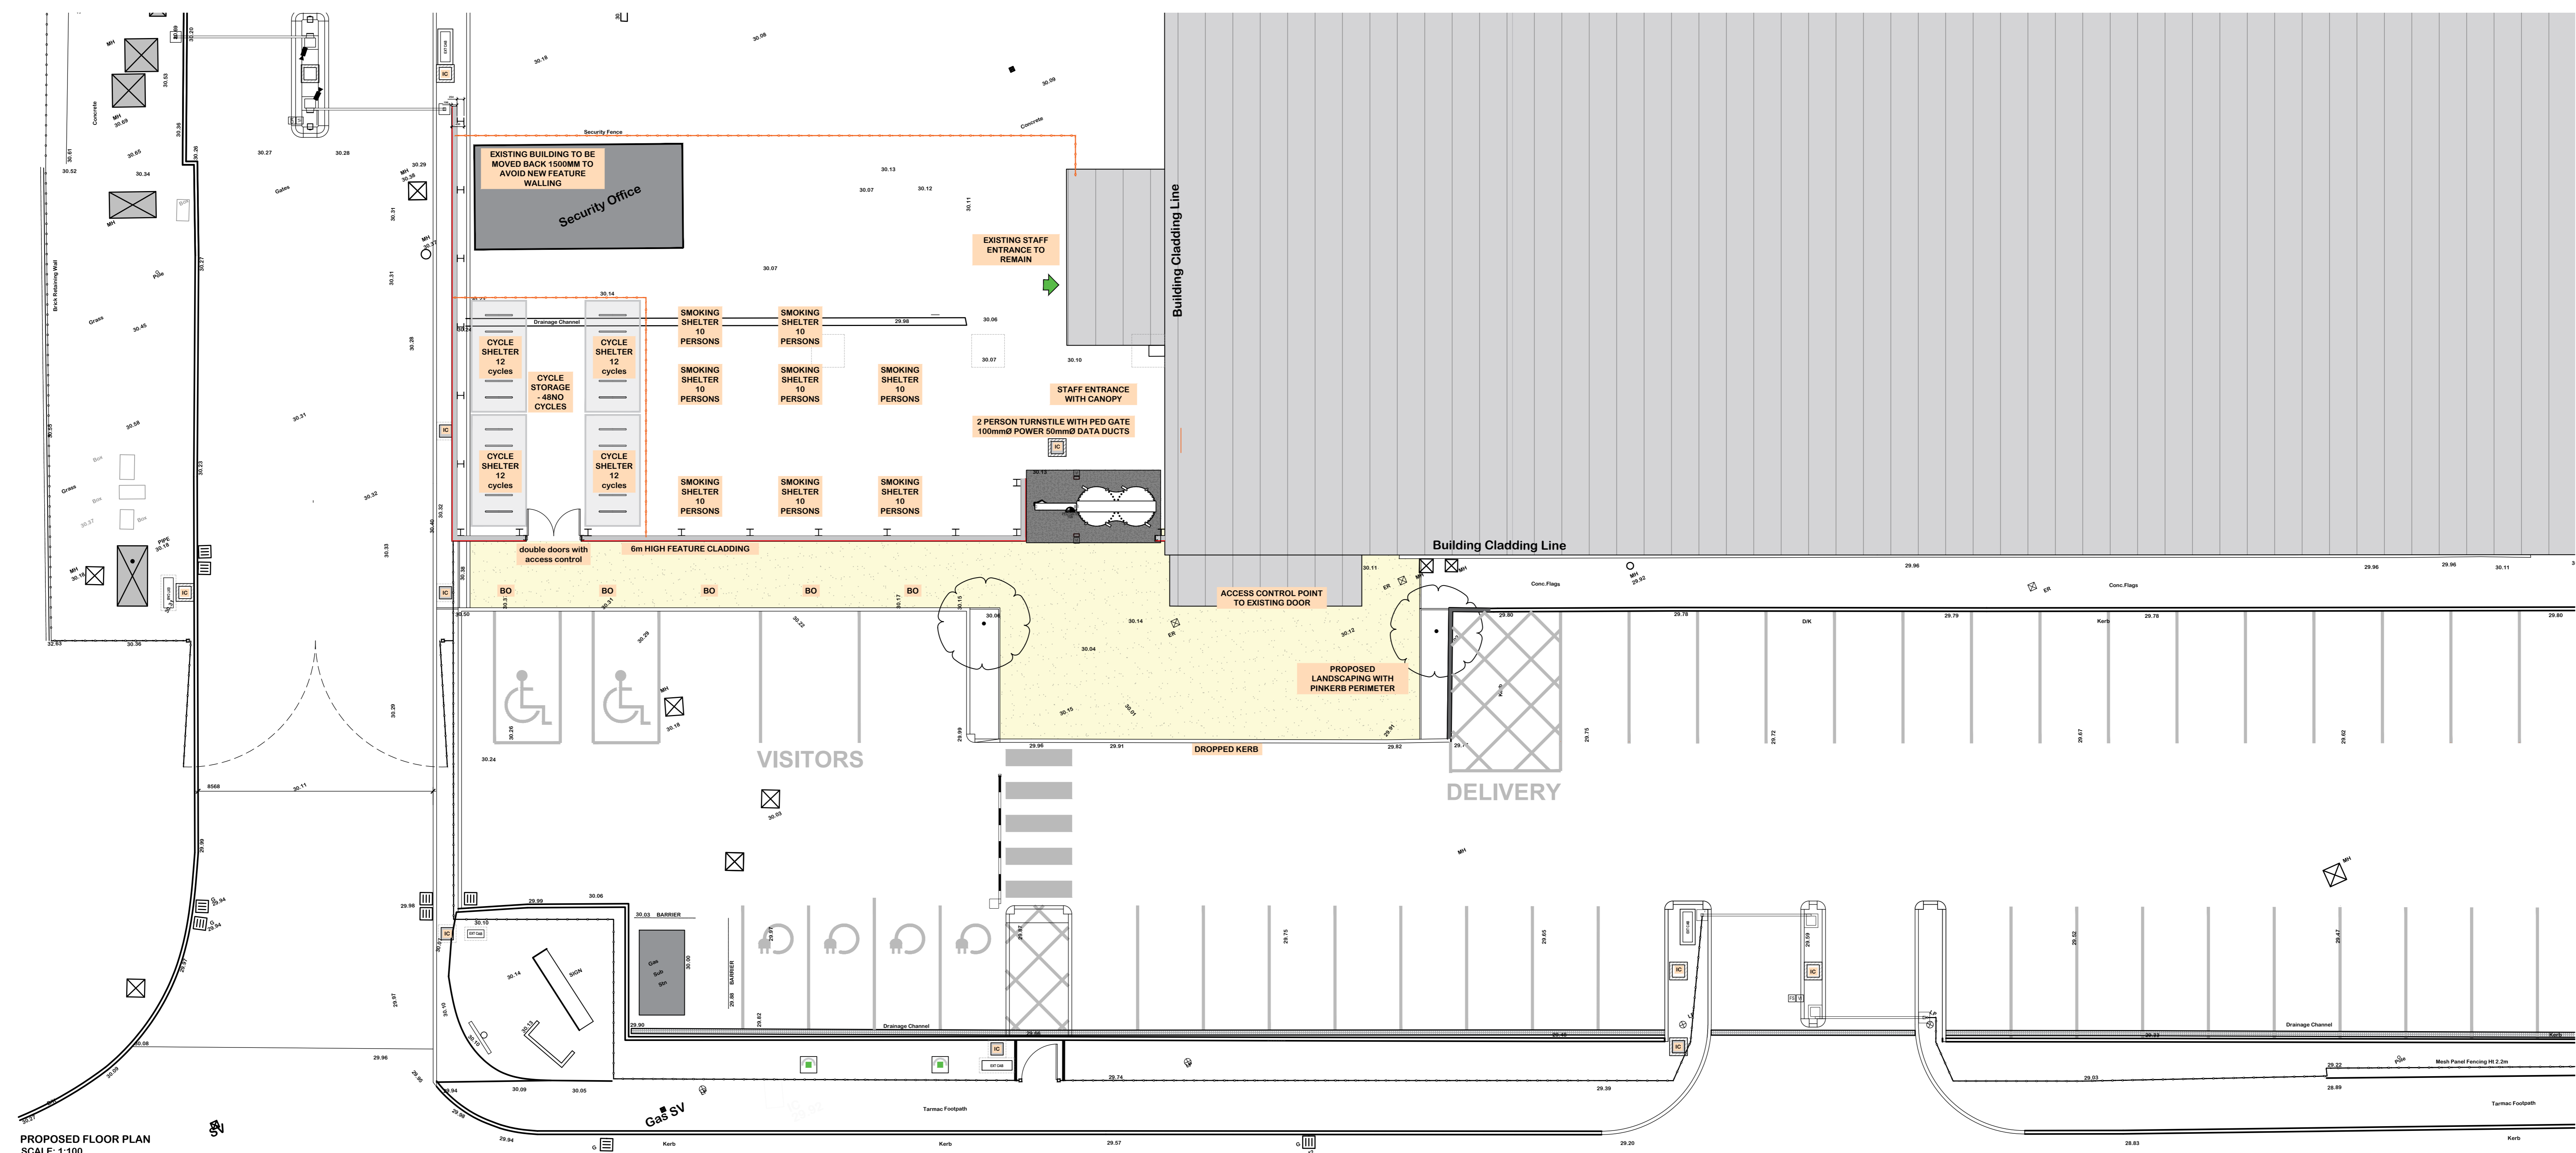

**PROPOSED LEGEND**

- EXISTING BUILDING
- EXISTING AREA PLANNED AND MADE GOOD
- PROPOSED 6m HIGH FEATURE WALL CLADDING
- PROPOSED 6m HIGH WITH WIND FENCING
- PROPOSED 1100mm HIGH STAINLESS STEEL VEHICLE BARRIER
- DOCKTRUCK BRACKLE
- PROPOSED EXTERNAL ELECTRICAL SUPPLY CAB TO SUIT BARRIERS
- TREES AND SHRUBS AS SHOWN ON PLAN

\* NB: ALL PROPOSED SITE AND FLOOR LEVELS TO MATCH EXISTING LEVEL HEIGHTS. ALL LEVELS ABOVE GROUND LEVEL WILL MATCH EXISTING.

**trundley**  
DESIGN SERVICES  
www.trundley.com

Salgate Barn  
Kilnston Road  
Tilney All Saints  
King's Lynn  
Norfolk  
PE34 4EY  
Tel: 01553 617700  
Fax: 01553 617874  
Email: enquiries@trundley.com

**WOMBWELL, BARNSELY S73 0UN  
EXISTING PRODUCTION FACILITY**

Drawing Title: PROPOSED ELEVATIONS AND FLOOR PLAN

Scale: AS STATED @ A0 Date: MARCH 2024 Drawn: AK

Drawing Number: 23-L66-PL004

Checked by: Date:

If this drawing is unsigned in the check box then the drawing is an unauthorised issue and should not be used for any purposes