

Simplified Upstream Elevation



Scale 1:100

**DO NOT SCALE - IF IN DOUBT ASK NOTES**

1. ALL DIMENSIONS IN MILLIMETERS (mm) UNLESS NOTED OTHERWISE.
2. DO NOT SCALE FROM THIS DRAWING.
3. DRAWING IS PRELIMINARY AND TO BE USED FOR PLANNING PURPOSES ONLY.
4. ALL ROAD/HIGHWAY DESIGN REQUIREMENTS TO HIGHWAYS DESIGN CONSULTING LONDON (9) SHALL DETAILS REFER TO SEPARATE DRAWINGS/DETAILS.
5. ALL FLOOD LEVEL DATA IS BASED ON FLOOD RISK ASSESSMENT INFORMATION PROVIDED BY WETWOOD SERVICES LTD. FOR DETAILS REFER TO SITE FLOOD RISK ASSESSMENT.
6. ENHANCEMENTS SHOWN INDICATIVELY ONLY AND SUBJECT TO DETAIL REVIEW OF GROUND CONDITIONS/SLOPE STABILITY BY THE GEOTECHNICAL ENGINEER (SRHSU LTD).
7. BRIDGE BEAMS AND HANDRAILS TO BE BS4801 (4C3) HOLLY GREEN.
8. DETAILS OF LIGHTING/LANDSCAPING TO BE CONFIRMED BY OTHERS.
9. THE SITE ECOLOGY REPORT HAS IDENTIFIED THE PRESENCE OF JAPANESE MONITORIED ON SOUTH BANK OF THE RIVER AT THE PROPOSED FOOTBRIDGE LOCATION. APPROPRIATE MITIGATION MEASURES TO BE IMPLEMENTED.
10. FOUNDATION DETAILS TBC AT DETAIL DESIGN STAGE.

Typical Section

Scale 1:50

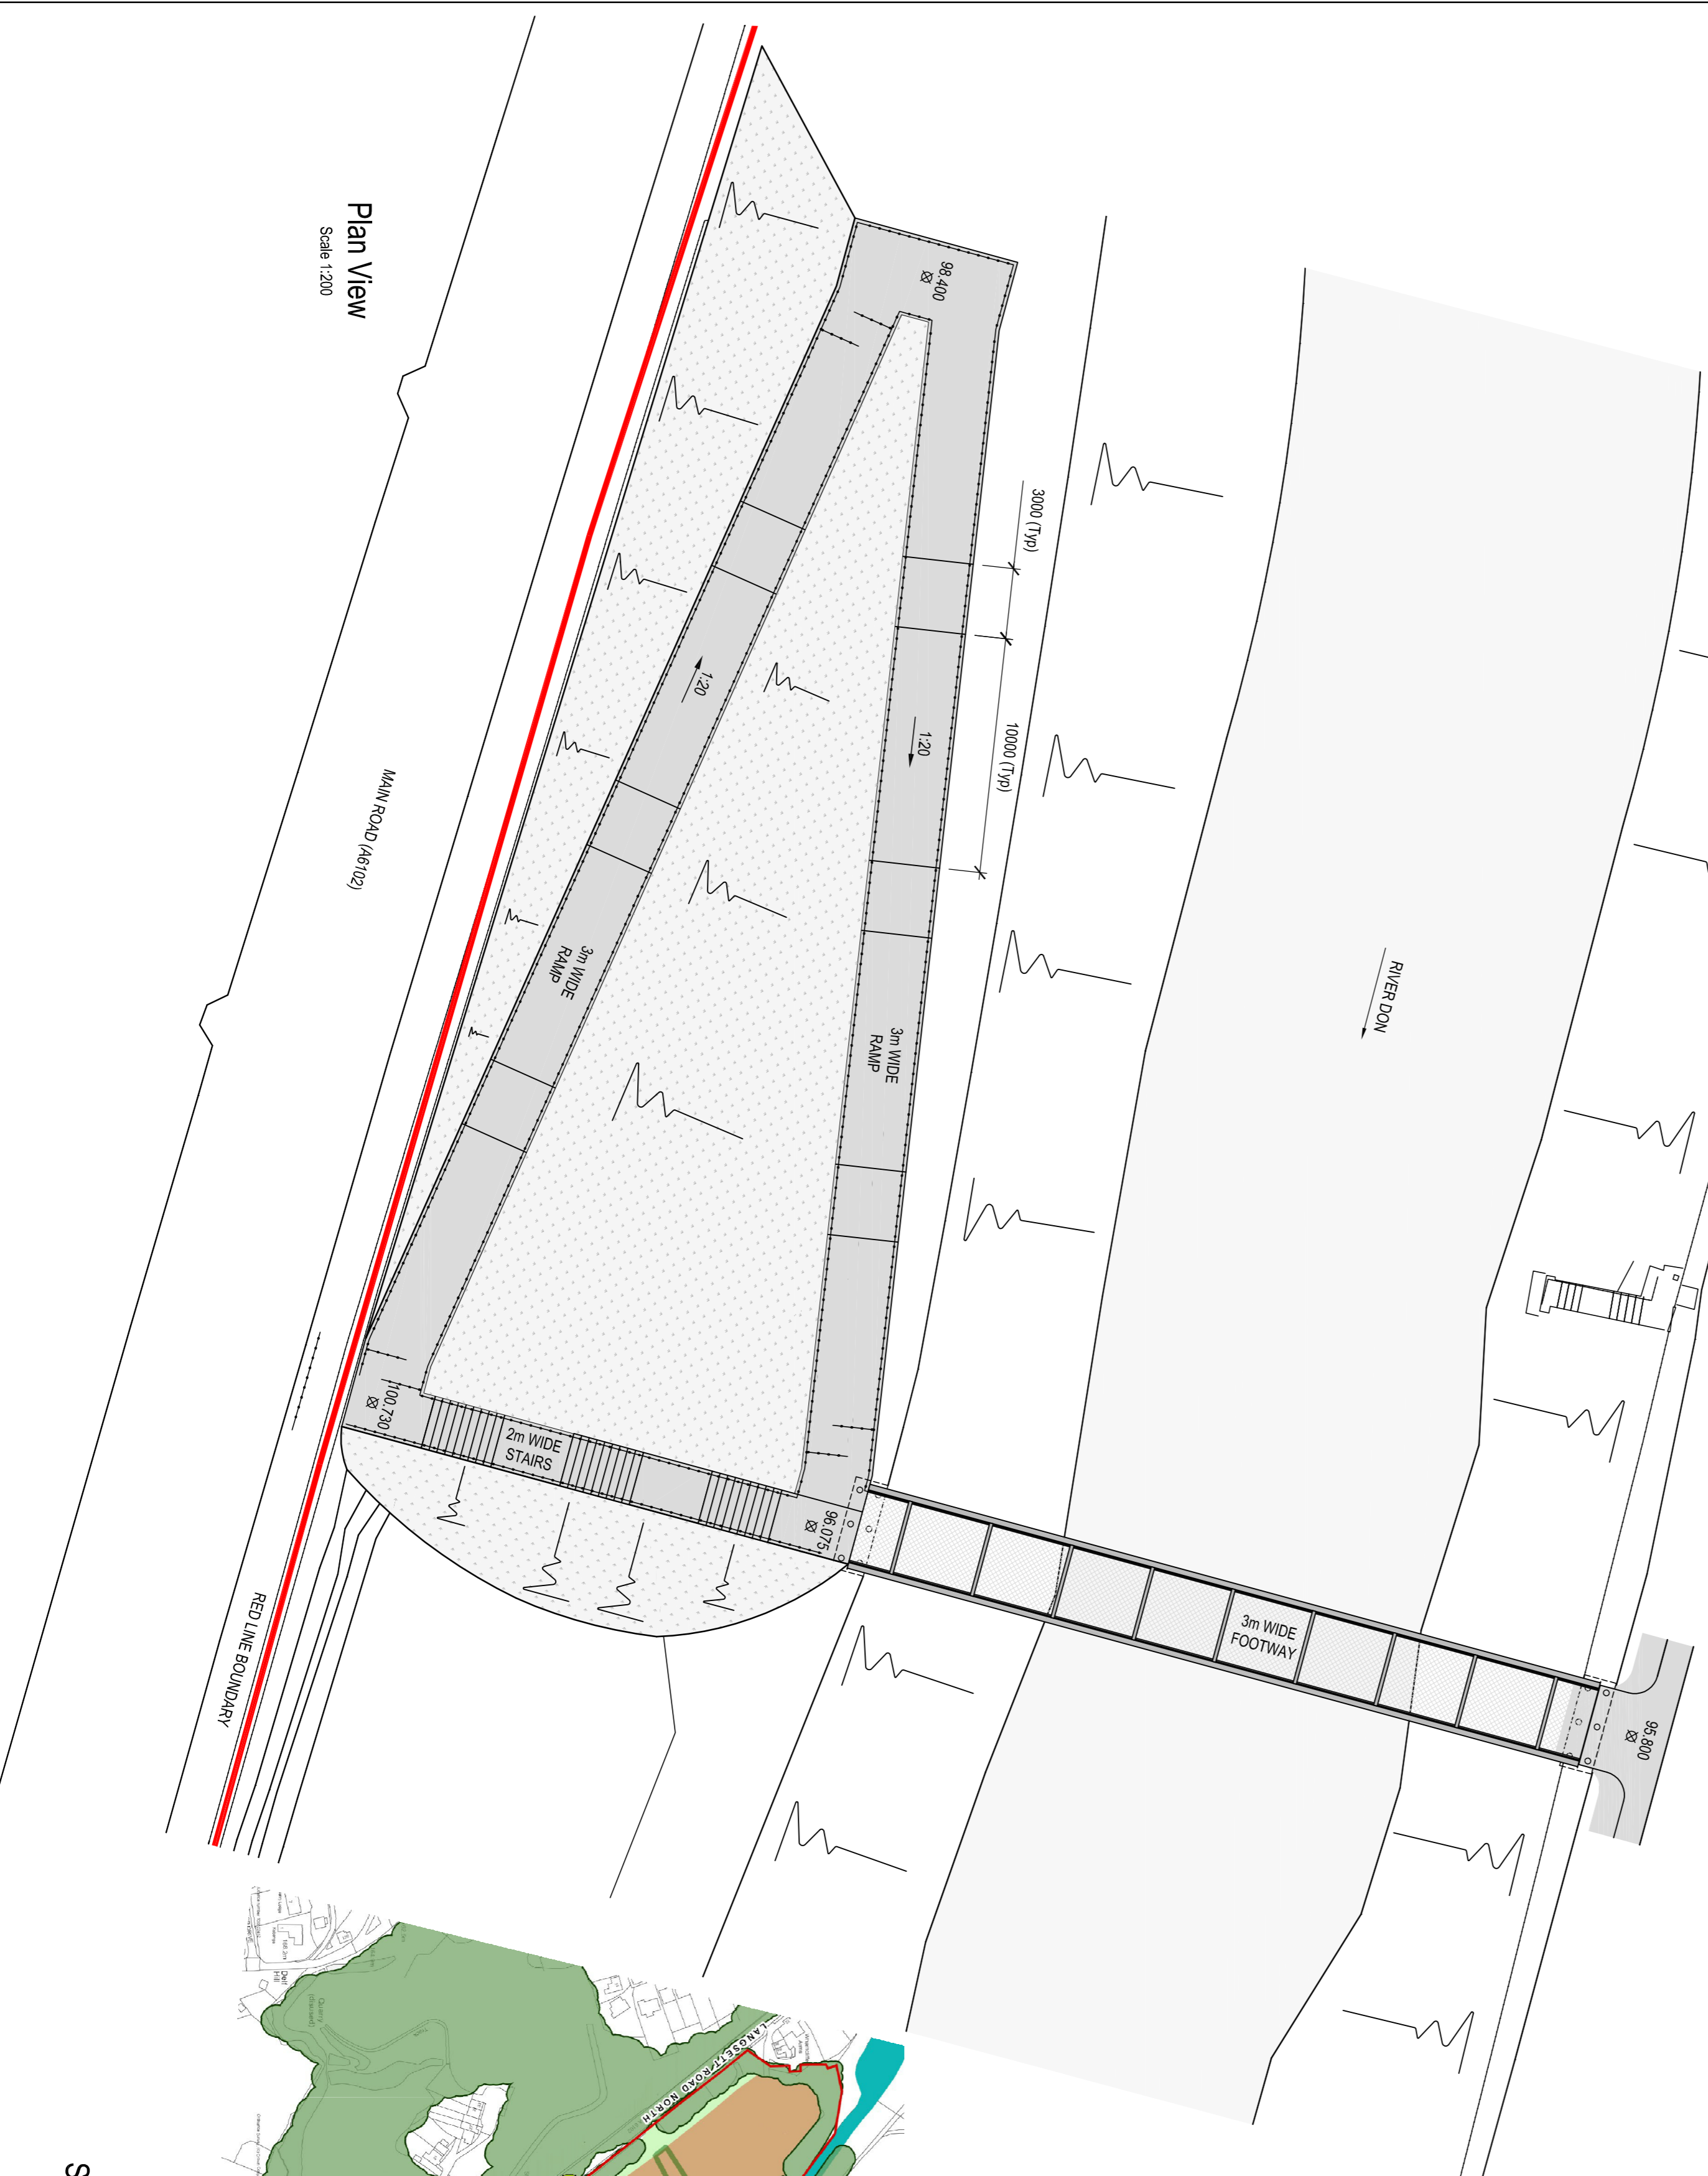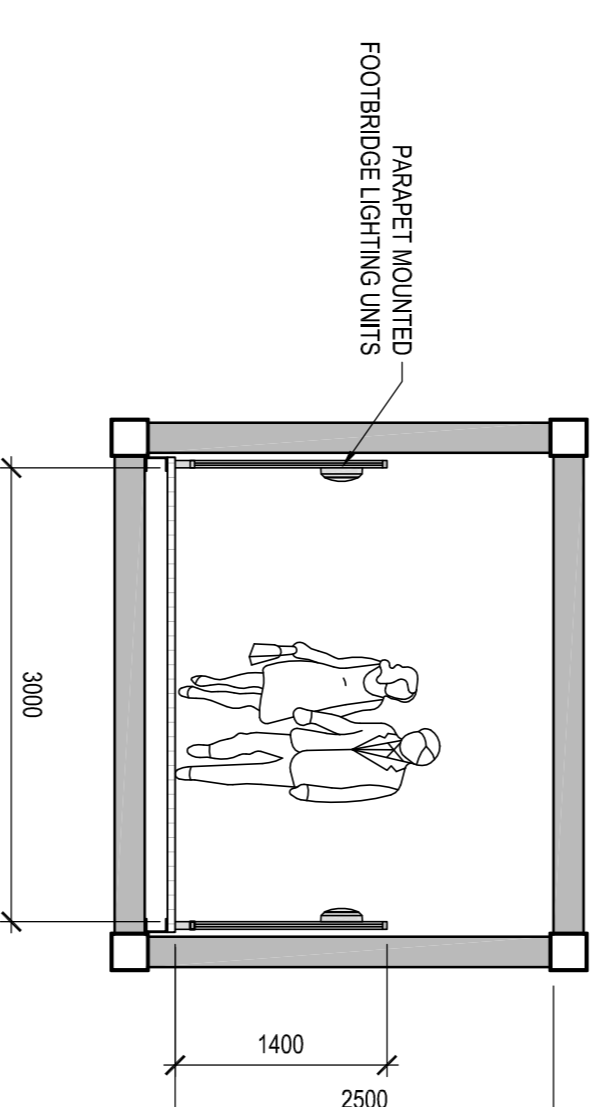


Plan View

Scale 1:200

Site Plan

NTS

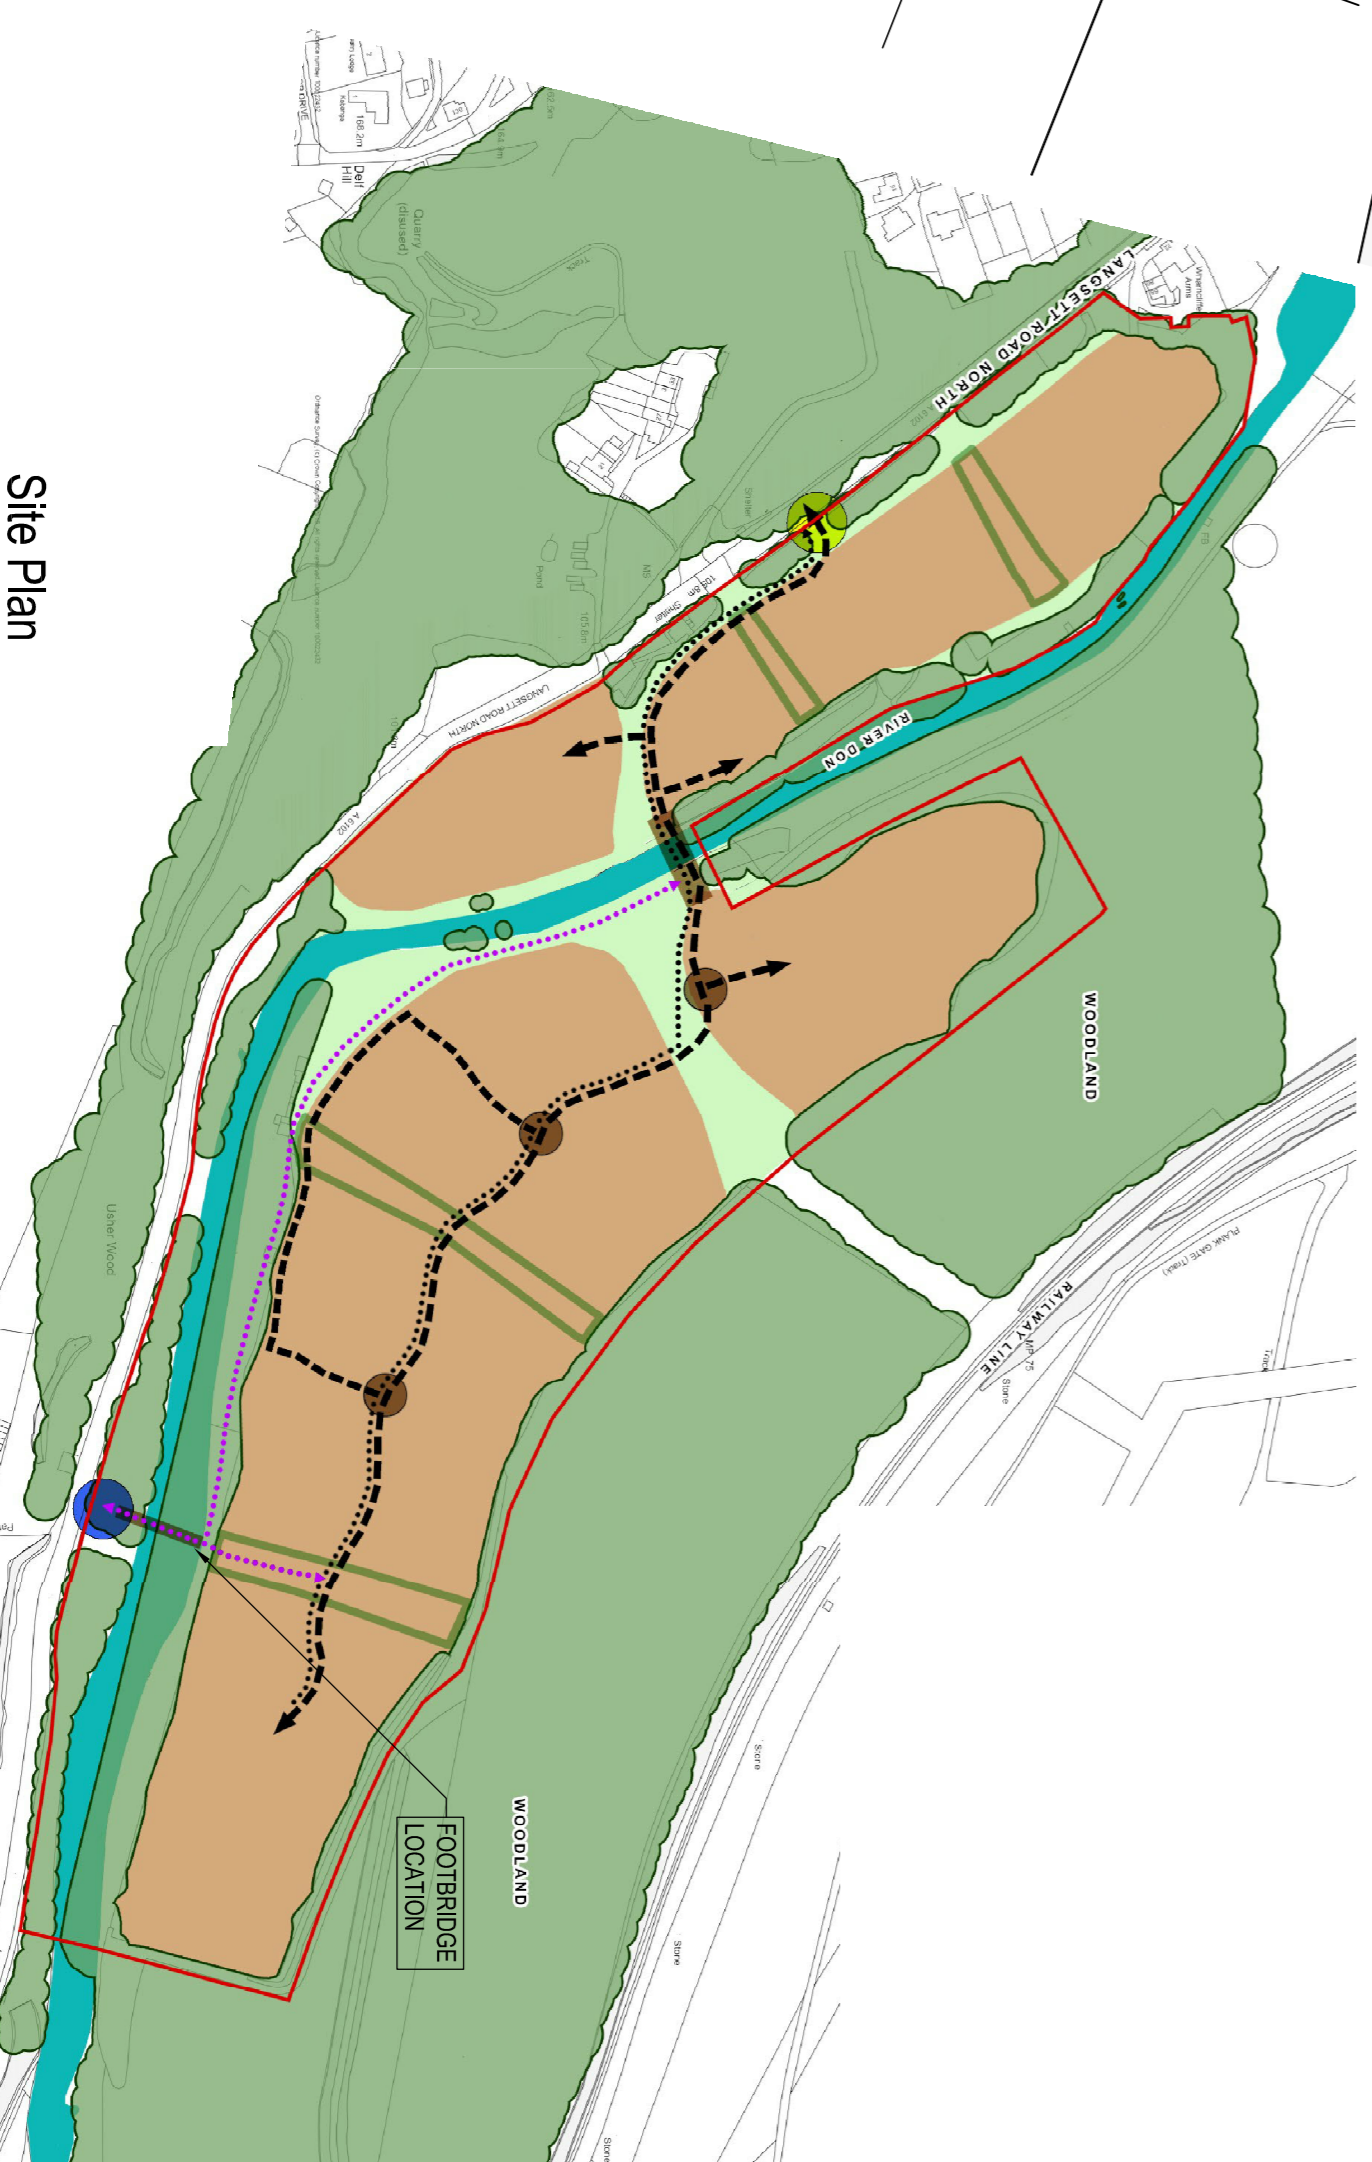

Rev	Date	Description	By	Chk	App
P1	15.04.16	PRELIMINARY ISSUE	MP	BA	BA
P2	21.04.16	1 IN 100 DESIGN FLOOD LEVELS REVISED. TOP RAMP BARBER AND VISIBAL ADDED.	MP	BA	BA
P3	23.04.16	1 IN 100 YEAR DESIGN FLOOD LEVEL + CLIMATE CHANGE ALLOWANCE + 600mm LEVEL REVISED	MP	BA	BA

Preliminary



Troy Mills  
Troy Road  
Horforth, Leeds  
LS18 5GN  
0113 259 1927  
info@ghdwinn.com

CLIENT  
C E G Ltd

PROJECT  
Oughtibridge Mills

TITLE  
Proposed Footbridge GA

SCALE	DRAWING SIZE	DRAWN	MP
As Shown	A1	MP	MP

DRAWING NO.	REV.
LS1611 BR01	P3