

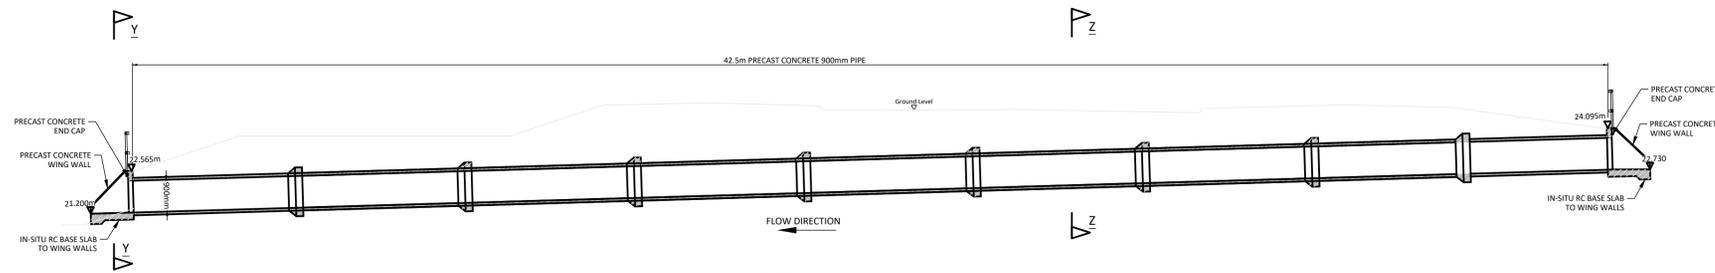



LOCATION PLAN  
SCALE 1:200

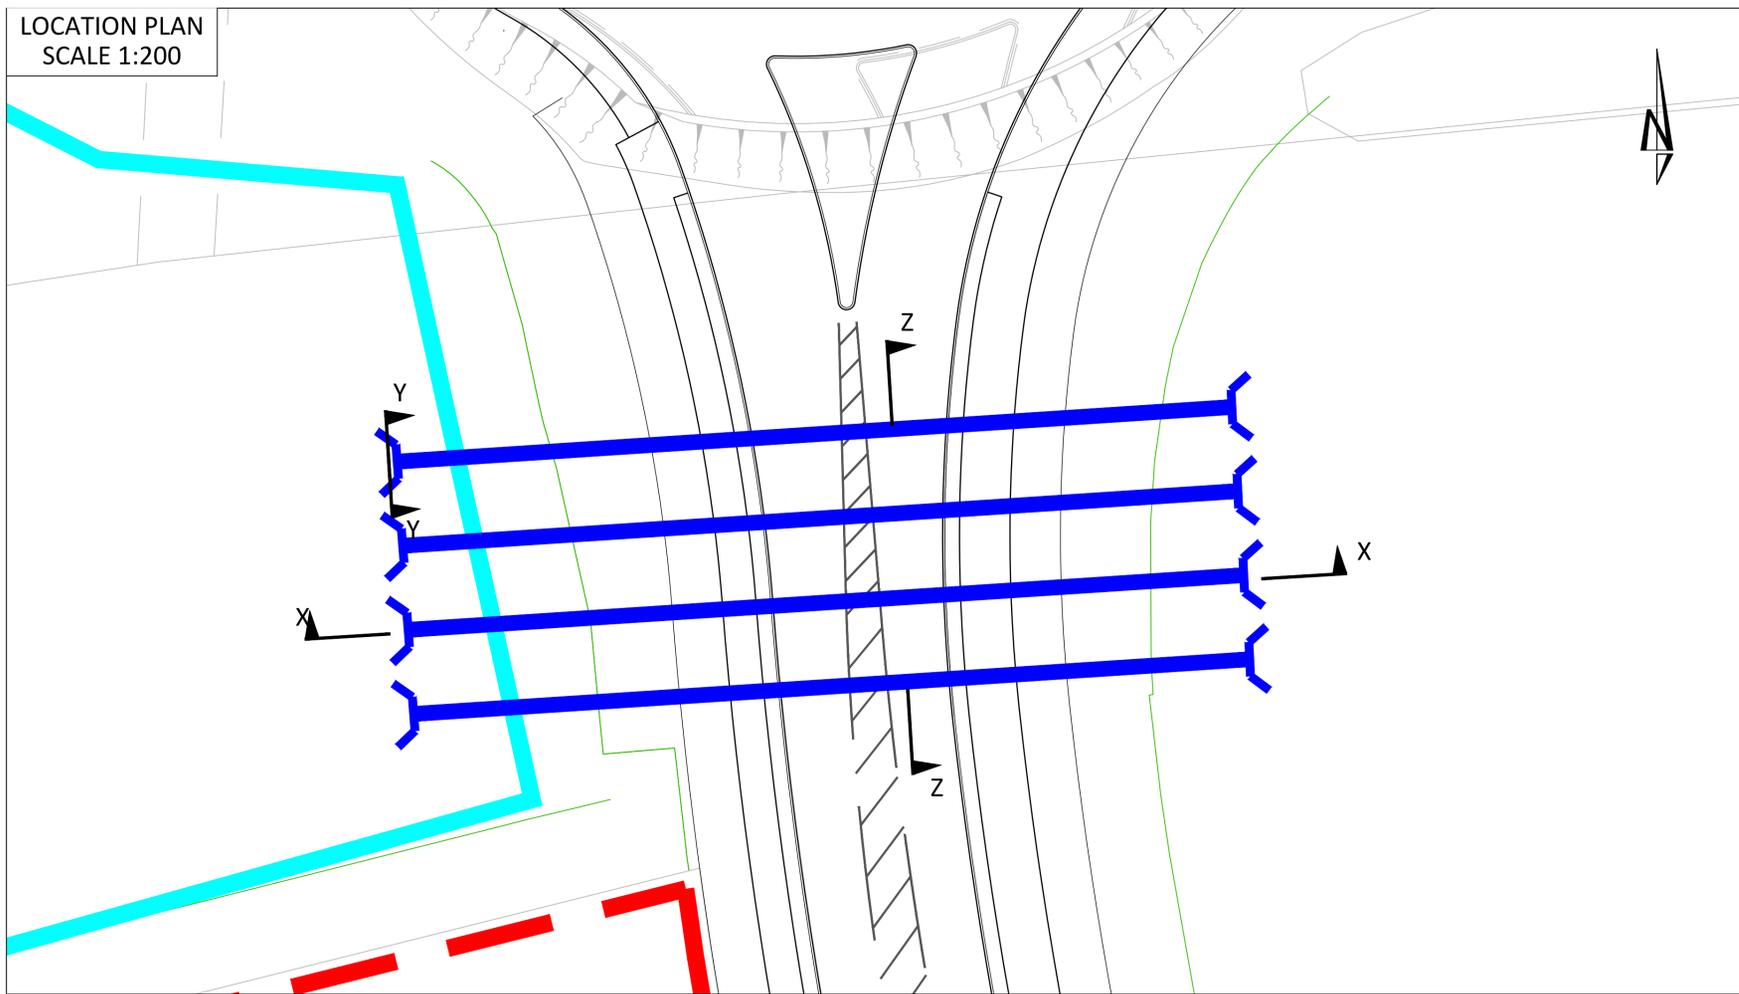


SECTION X-X  
SCALE 1:100

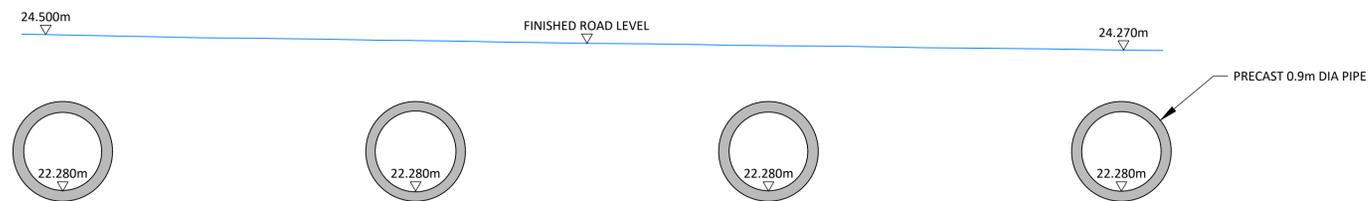

SECTION Z-Z  
SCALE 1:50

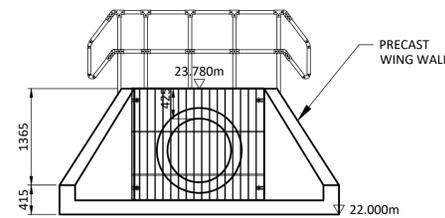

SECTION Y-Y  
FRONT ELEVATION ON WING WALLS  
SCALE 1:50

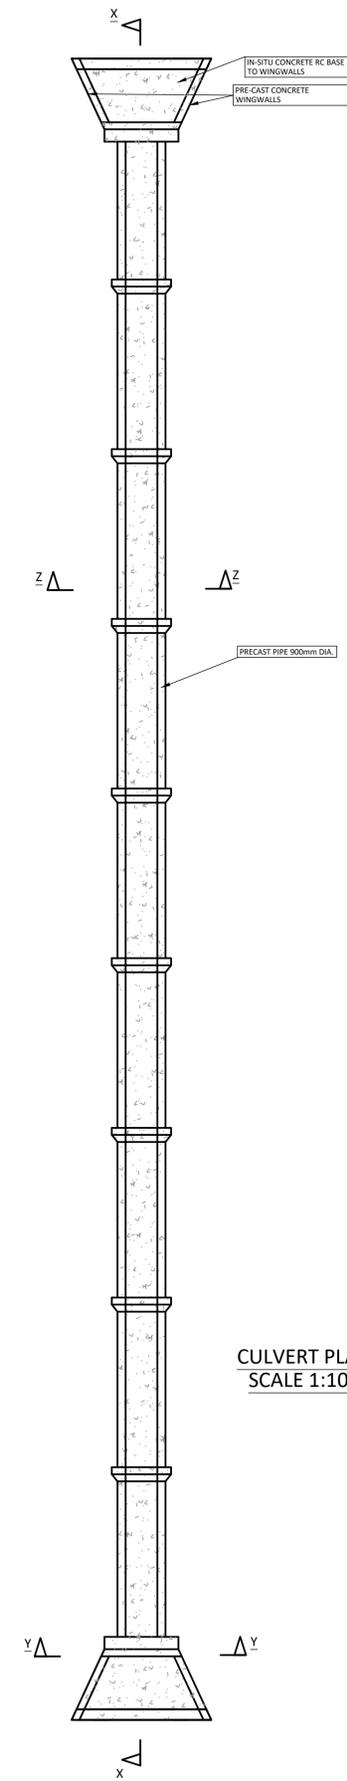

CULVERT PLAN  
SCALE 1:100

- Notes:
- All dimensions are to be checked on site before the commencement of works. Any discrepancies are to be reported to the Architect & Engineer for verification. Figured dimensions only are to be taken from this drawing.
  - This drawing is to be read in conjunction with all relevant Engineers' and Service Engineers' drawings and specifications.

SAFETY, HEALTH AND ENVIRONMENTAL INFORMATION	
IN ADDITION TO THE HAZARDS/RISKS NORMALLY ASSOCIATED WITH THE TYPES OF WORK DETAILED ON THIS DRAWING, NOTE THE FOLLOWING	
CONSTRUCTION	
MAINTENANCE / CLEANING	
DECOMMISSIONING / DEMOLITION	
IT IS ASSUMED THAT ALL WORKS WILL BE CARRIED OUT BY A COMPETENT CONTRACTOR WORKING, WHERE APPROPRIATE, TO AN APPROVED METHOD STATEMENT	

NOTE: DEPENDING ON MANUFACTURER - EXACT PRECAST SIZES MAY VARY BUT CAPACITY WILL NOT BE REDUCED

NOTE: FOR THE AVOIDANCE OF DOUBT, THE INFORMATION SHOWN WITHIN THE DEVELOPMENT PLOTS IS INDICATIVE ONLY, AND WILL BE SUBJECT TO SUBSEQUENT RESERVED MATTERS APPLICATIONS

Rev	Date	Description	By	Ckd
P4	31.01.2025	Flood Conveyance Channel updated	JK	NB
P3	23.11.2023	Updated in line with client comments	SJ	NB
P2	08.06.2023	Note added	SJ	NB
P1	21.02.2023	Planning issue	SJ	NB



Client:  
**BARNESLEY ROAD GOLDTHORPE**

Drawing Title:  
**FLOOD CONVEYANCE CHANNEL ROAD CULVERT DETAILS**

Drawing Status:  
**PLANNING**

Hydrock Job No: **C23451**

Drawn	Checked	Scale @ A1	Date	Issue Date
SJ	NB	AS SHOWN	21.02.2023	21.02.2023

Drawing Number: **23451-HYD-XX-XX-DR-D-0512** Revision: **P4**