

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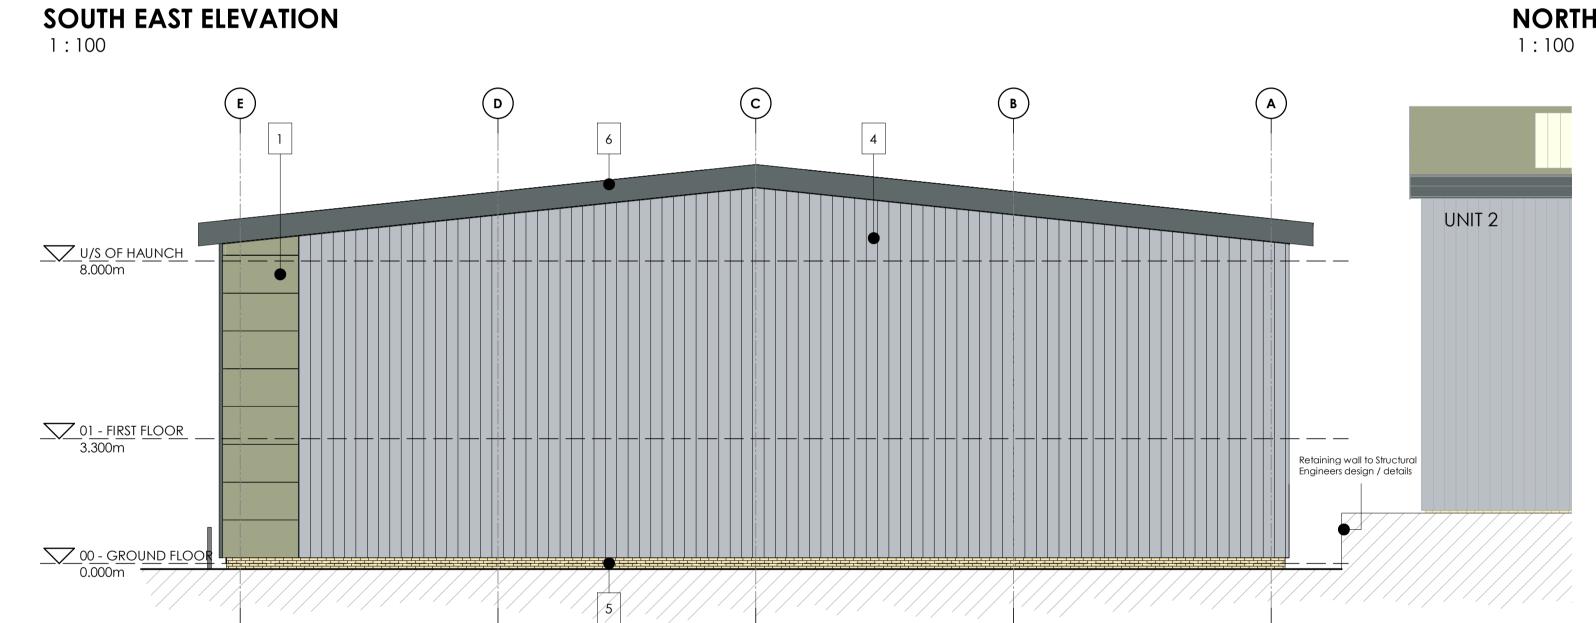
and request updated data if required.

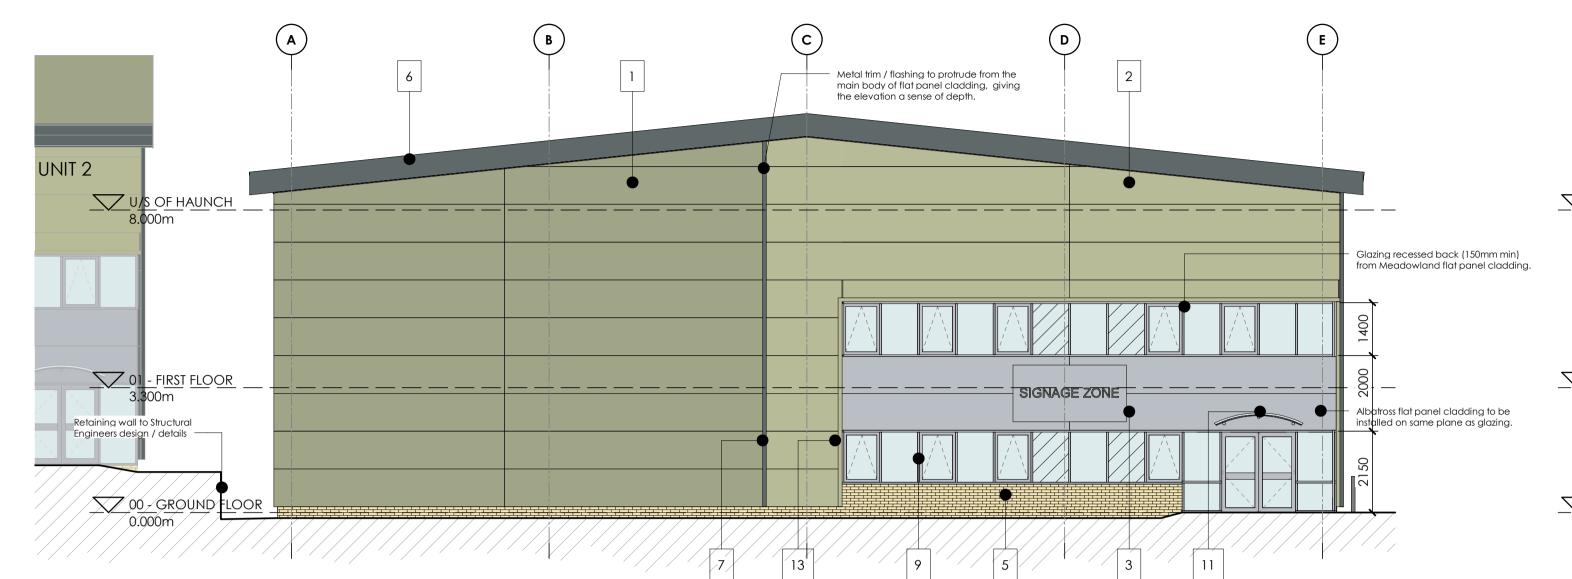

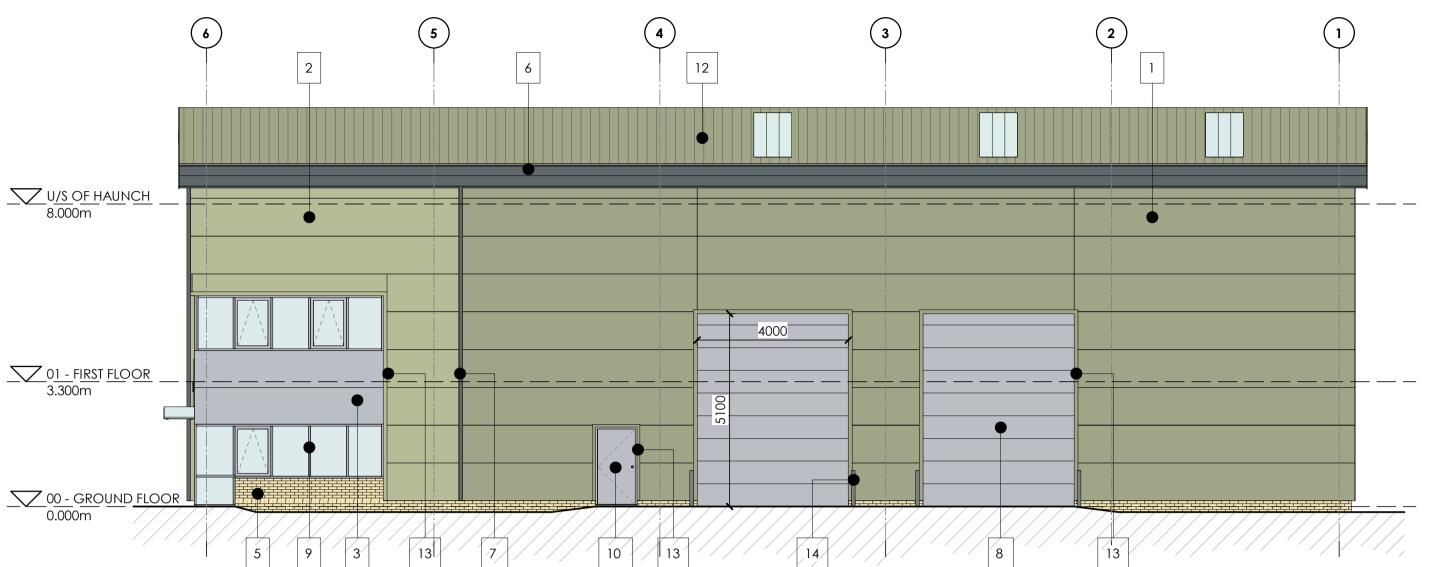

NORTH EAST ELEVATION

1:100



Trapezoidal cladding and flat panel cladding to be installed on same plane.

This drawing is to be read in conjunction with all other relevant Architects, Engineers & Sub - Contractors drawings / Details.

This drawing is subject to Client and Building Control Approval.

Final Steelwork and grid layout is subject to specialist steel design.

Any foundations / floor slab shown are diagramatic and subject to specialist design / details.

<u> </u>			Scale 1 : 100_
0 1	2	5	10 m

KEY	MATERIAL SPECIFICATION	MATERIAL COLOUR	TATA STEEL CODE	
1	Tata Trimapanel micro-rib (or similar approved) panel cladding system, with factory finish.	Moorland Green	12B21	
2	Tata Trimapanel micro-rib (or similar approved) panel cladding system, with factory finish.	Meadowland	12B17	
3	Tata Trimapanel micro-rib (or similar approved) panel cladding system, with factory finish.	Albatross	18B17	
4	Tata Trisomet (or similar approved) trapezoidal cladding system, with factory finish.	Albatross	18B17	
5	Brickwork	Buff Brick + Natural Mortar	N/A	
6	PPC aluminium (or similar approved) facias and soffits	Merlin Grey	18B25	
7	Factory finished steel feature flashings	Merlin Grey	18B25	
8	Insulated sectional overhead loading doors, with factory finish.	RAL 9006	N/A	
9	PPC aluminium windows/door frames, double galzed with anti-sun glass.	RAL 9006	N/A	
10	High security factory finished steel pedestrian doors	RAL 9006	N/A	
11	Glass canopy, with painted steel frame	RAL 9006	N/A	
12	Tata Trisomet (or similar approved) trapezoidal roof cladding system, with factory finish.	Moorland Green	12B21	
13	Factory finished steel flashings	To match cladding	N/A	
14	Bollards	Gloss painted steel RAL 9006 with yellow horizontal stripes.	N/A	

P6	Glazing recess amended to 150mm	SW <	566	19.12.23
P5	Minor amendment.	IR	SW	10.07.23
P4	Glazing amended.	IR	SW	29.06.23
P3	Unit 2 added for context, metal trim note amended.	IR	SW	30.05.23
P2	First floor windows amended to have panels above opening lights, 600mm cladding panel removed below window.	IR	SW	16.05.23
Ρl	Issued for Planning	IR	SW	20.04.23
Rev	Description	Drn	Vf'd	Date
can u the de Regula this dr	lined in section 2.3 of the CITB Industry Guidance to sually be ignored, as can risks arising from routine cossign compounds or significantly alters these risks. In ations 8, 9 and 11, any significant risks relating to the awing have been identified and are annotated thu No significant risks have been identified. Significant risks have been identified - refer to no drawing for information on residual risks and any measures to be employed.	onstruction accorded design for struction struction design for struction	n activiti ance with eatures st	es, unless CDM
Des	igner's Signature SW	Dat	te Mc	ar'23

Drawing Status PLANNING

architecture: engineering: building consultancy

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Client				
Carnell	Manc	agement	t Services Lt	d.
Title				
Unit 1 Pr	opose	ed Eleva	itions	
WS Project No. 12215	Drawn by	Date Mar'23	As indicated	@ A1
D	ont Doforon			

12215 - WMS - 01 - ZZ - D - **A - 10601 -** S8 - P6

SOUTH WEST ELEVATION

NORTH WEST ELEVATION

12

1:100

U/S OF HAUNCH 8.000m

01 - FIRST FLOOR 3.300m

00 - GROUND FLOOR 0.000m

1:100